

PICTURE STAGE LEFT FIRST GALLERY FRAMING TO HISTORIC WALL CONNECTION.
NOTE THE HISTORIC AND THE NEW MEMBERS.



PICTURE 2 STAGE LEFT FIRST GALLERY FRAMING TO NEW STEEL CONNECTION.

ASSOCIATES

ALMOND

KILLIS

CONSTRUCTION

NOT FOR

CONDITIONS

ANTONIO, TEXAS FAX (210) 532—9

342 WILKENS (210) 532-



PICTURE 4 STAGE LEFT FIRST GALLERY PIN RAIL. SEE



DETAILS ON A 1.3.



PICTURE 6 STAGE LEFT FIRST GALLERY I- BEAM





PICTURE 8 STAGE LEFT FIRST GALLERY SIDE VIEW OF PIN RAIL MEMBER TO I-BEAM CONNECTION





MARCH 07, 2005

DRAWN BY

MVA, FB
CHECKED BY
KPA

project number 05-09

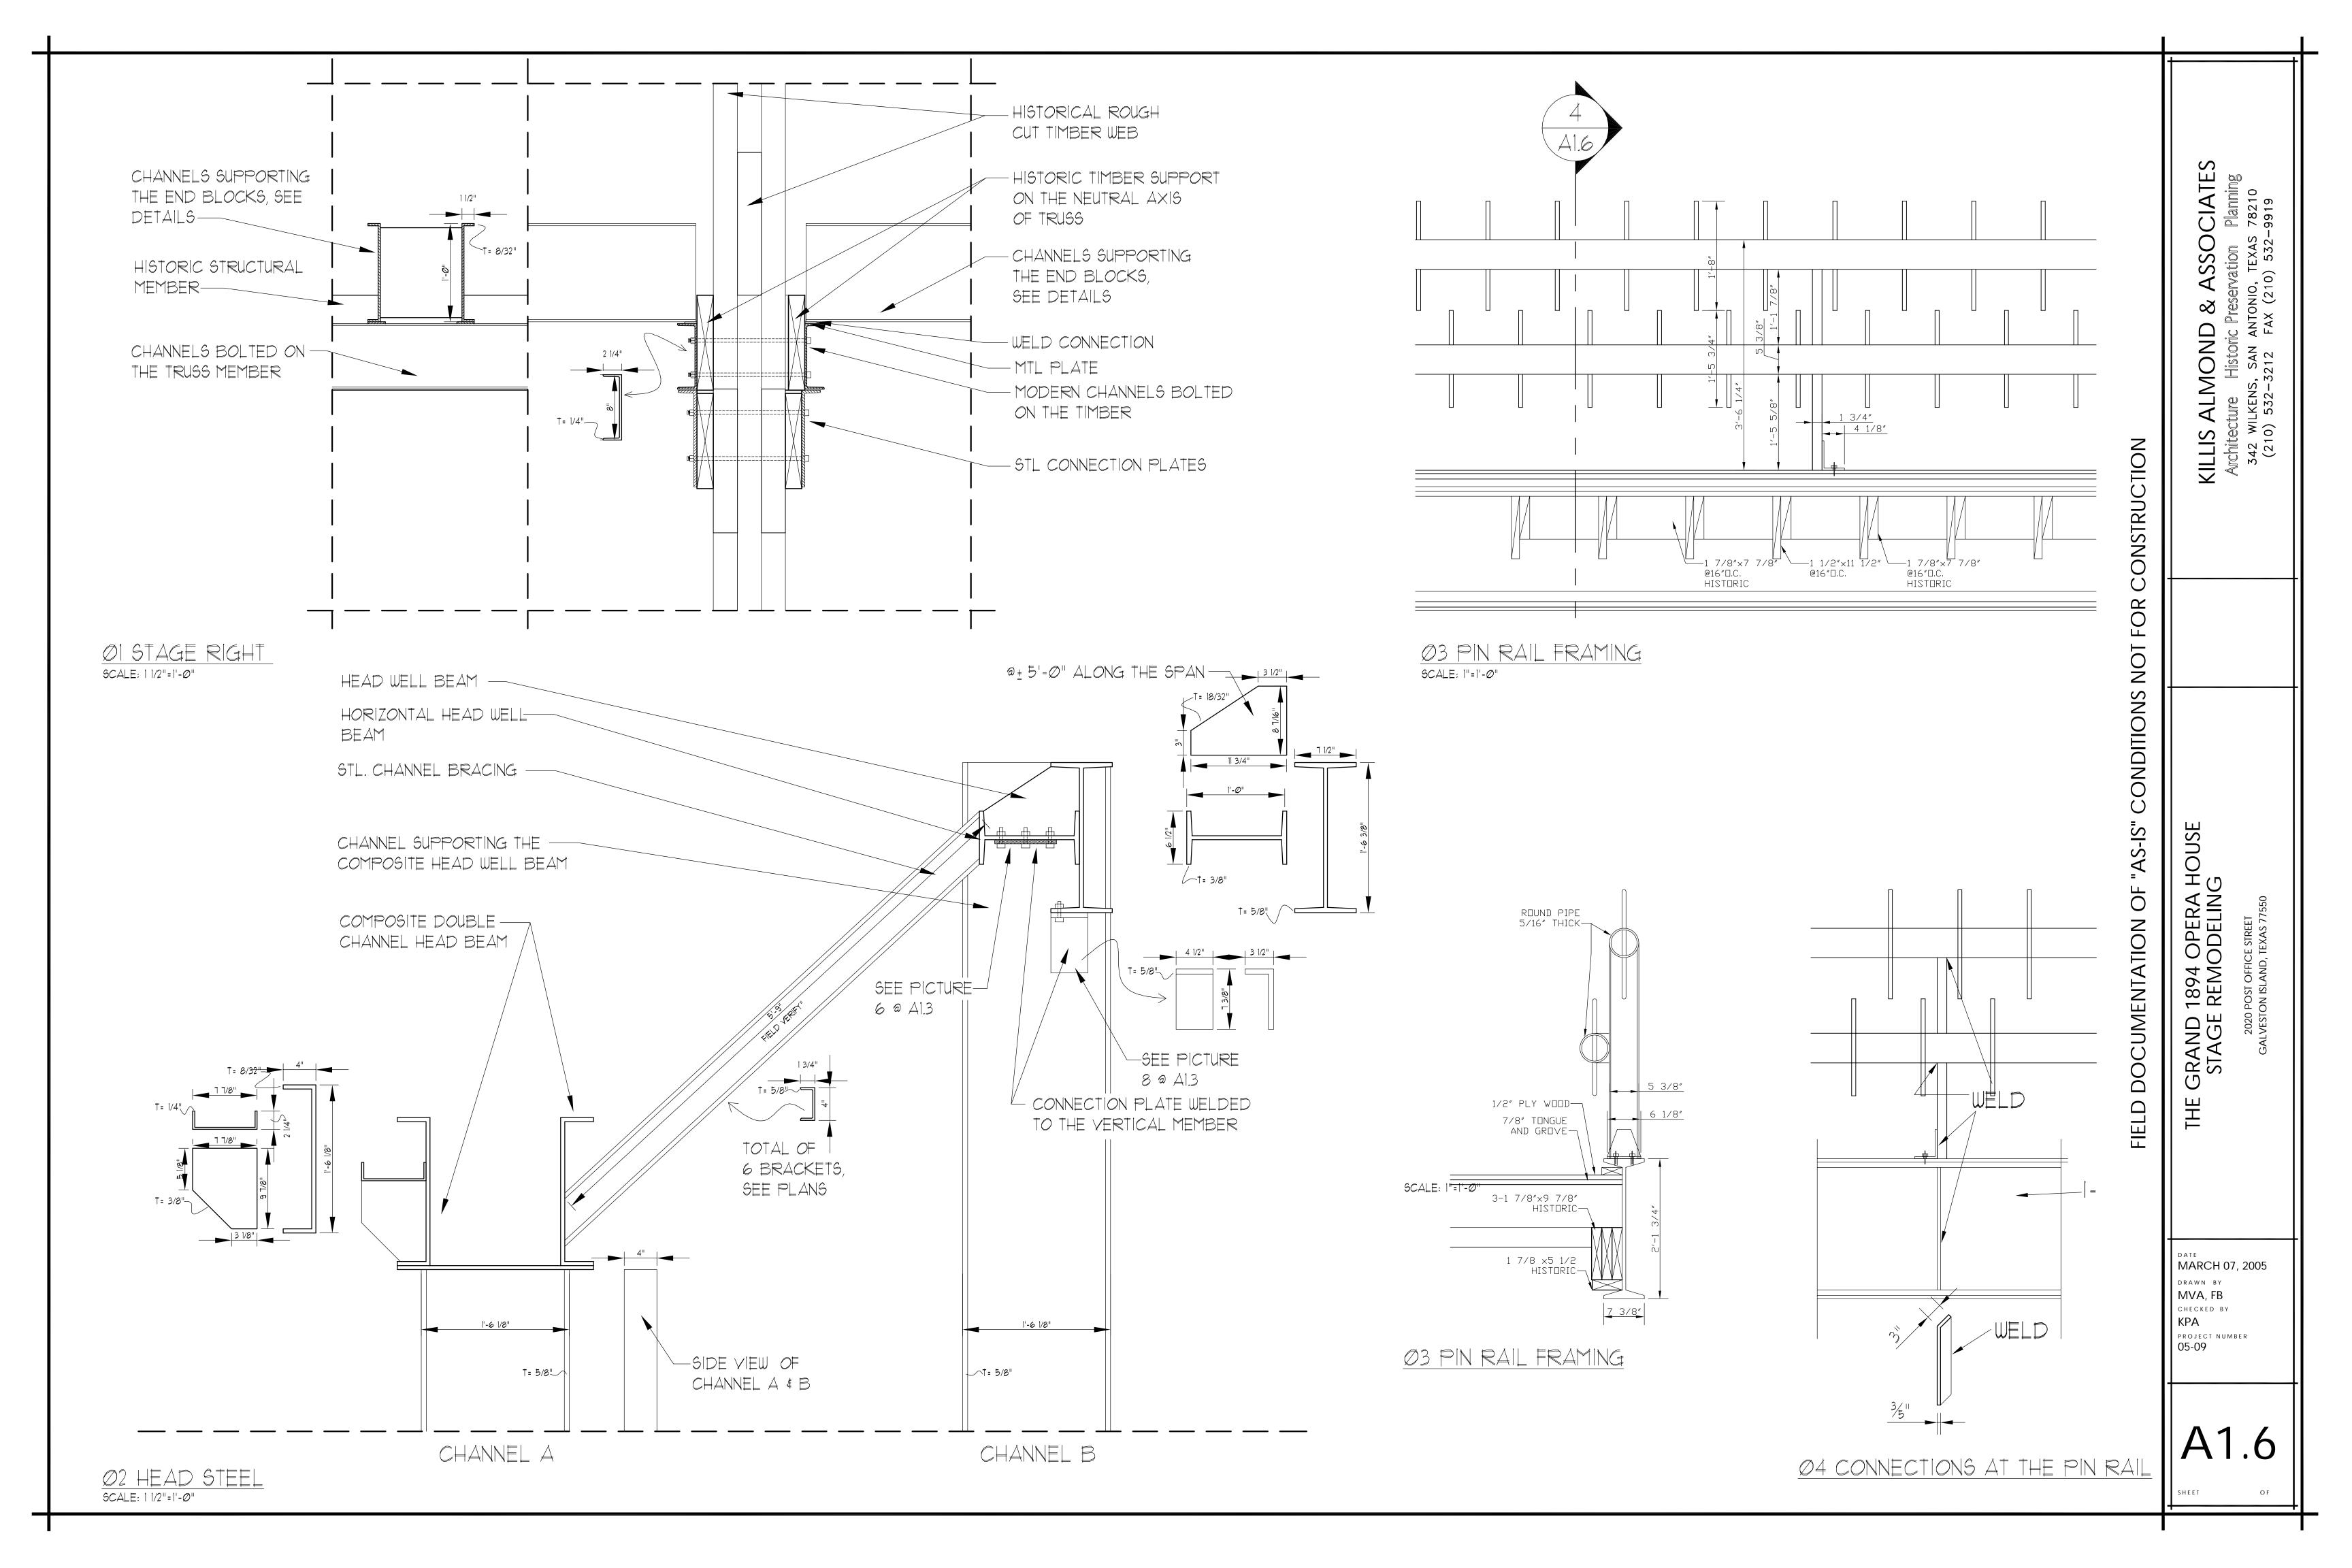

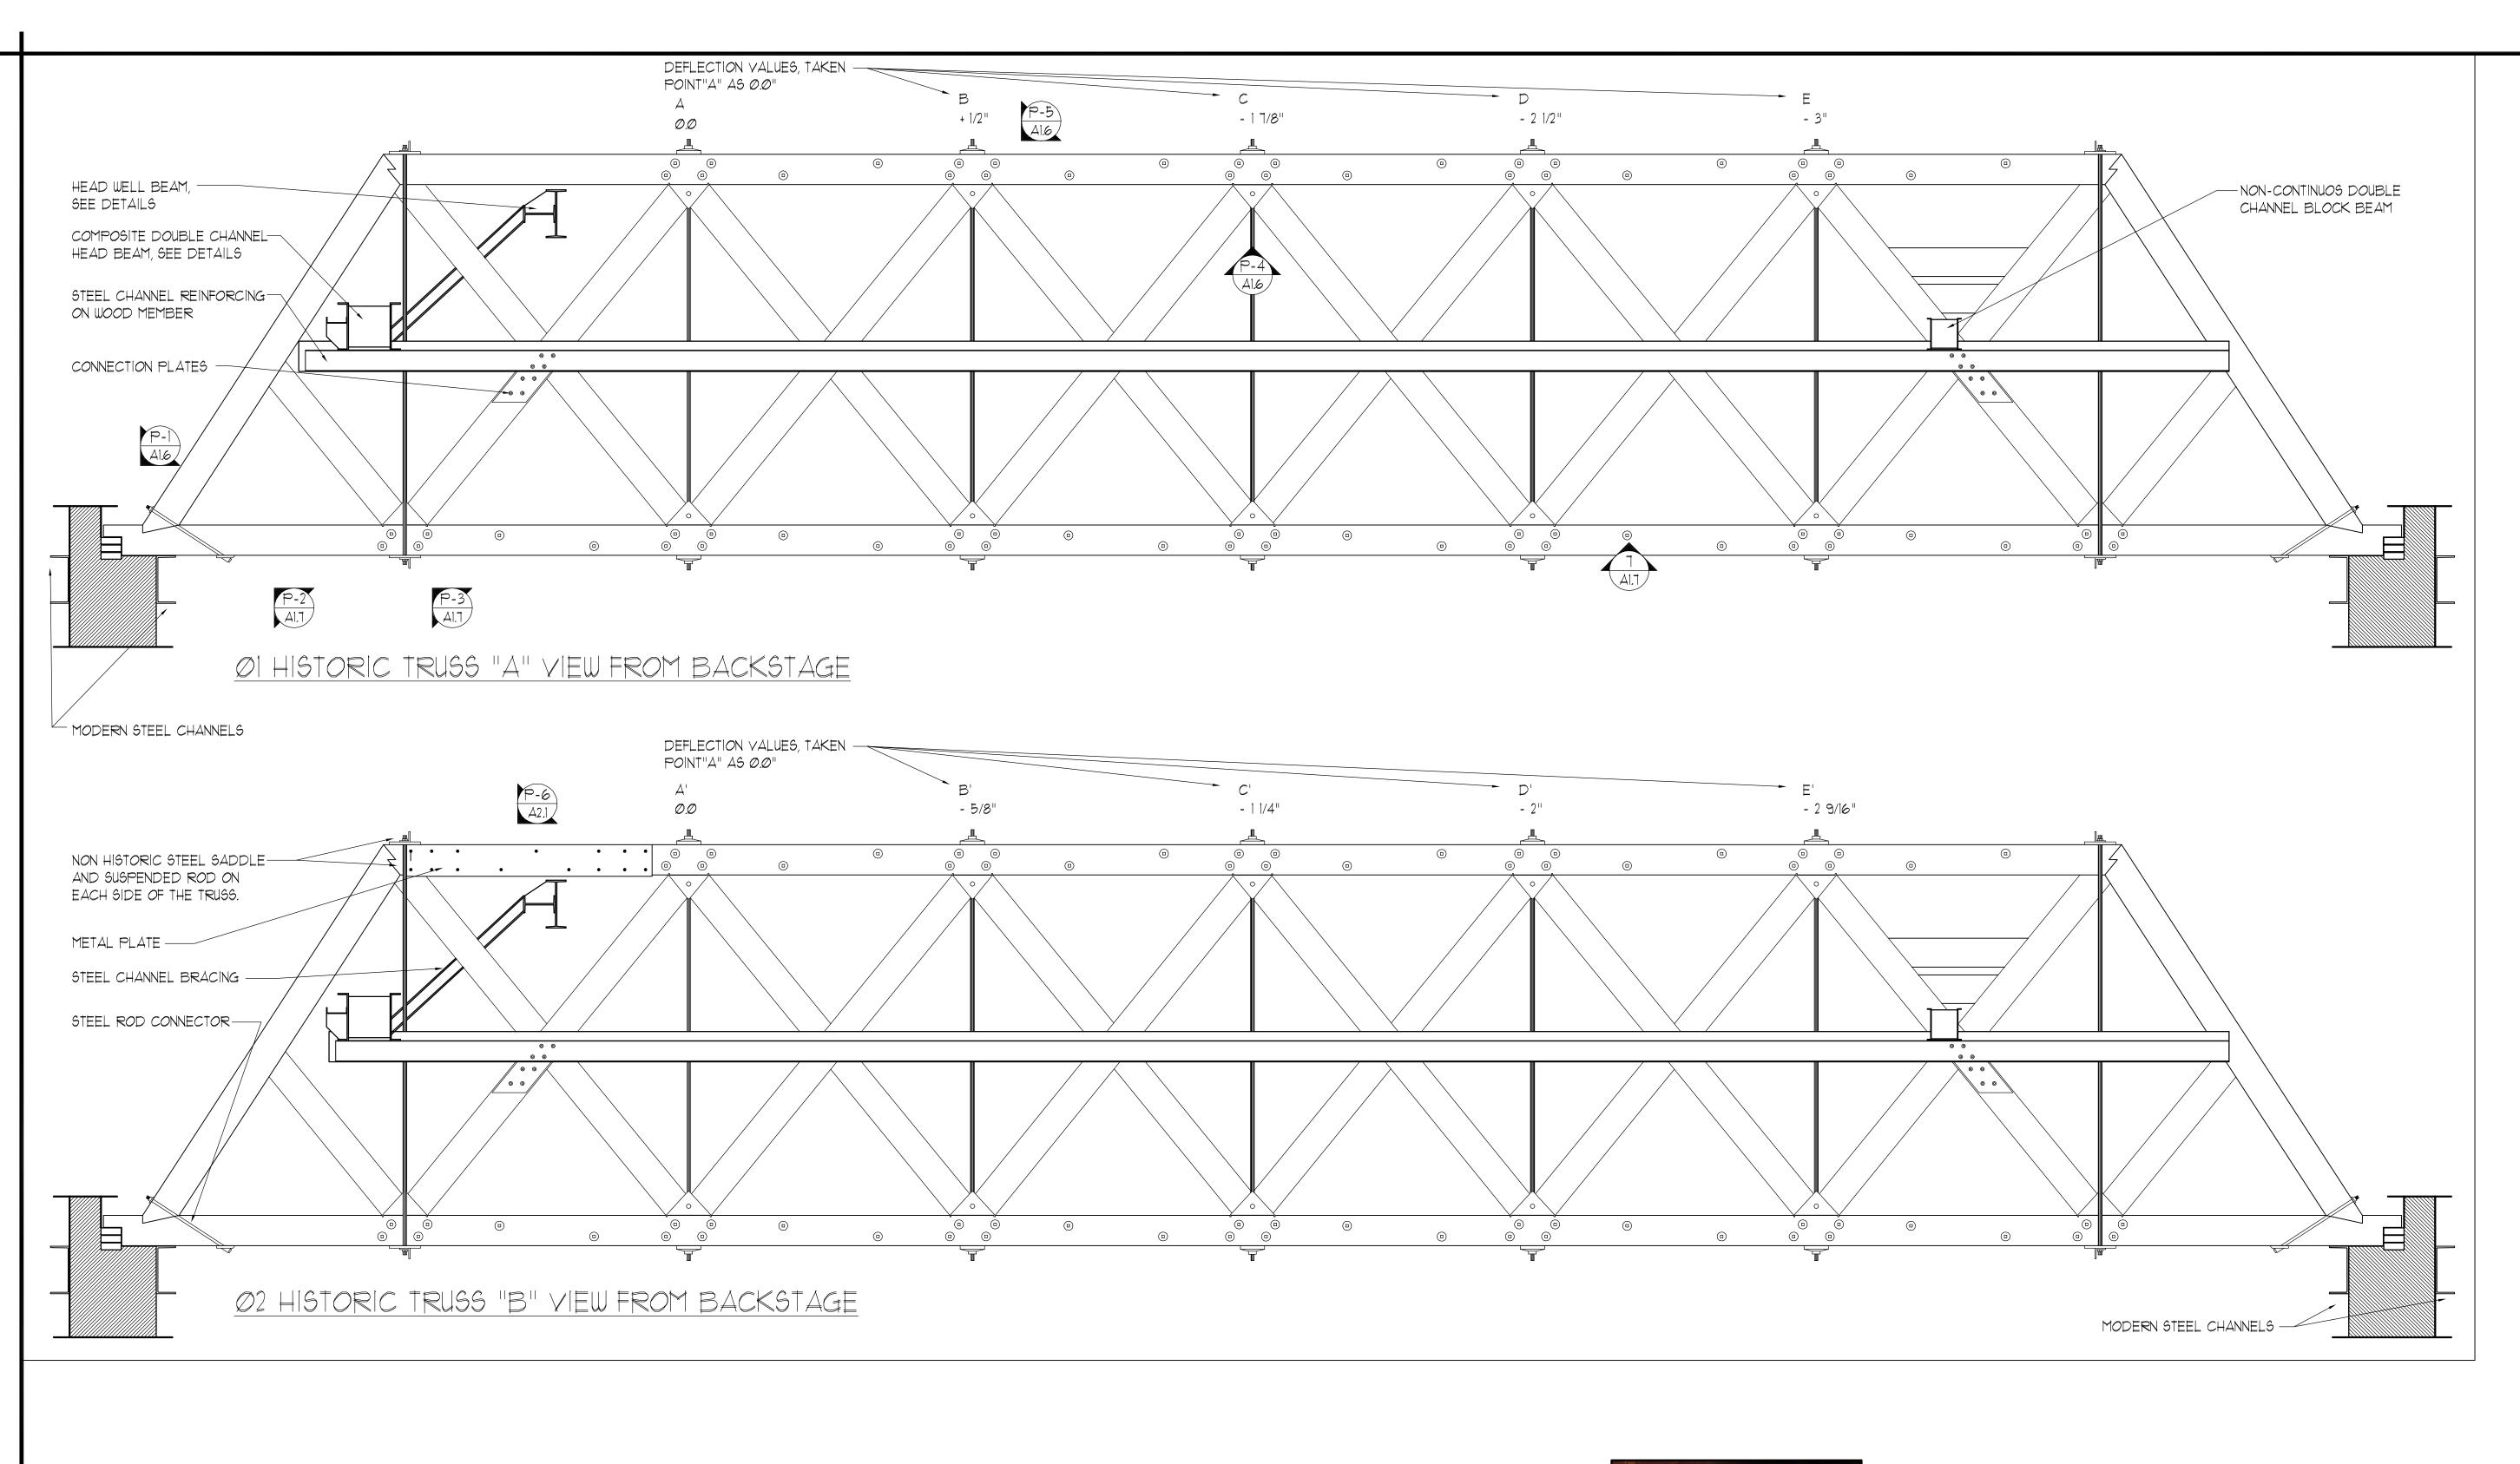



PICTURE 1

HISTORIC TRUSS TO LOAD
BEARING WALL CONNECTION



PICTURE 2

UNDER SHOT OF THE BOTTOM CHORD
WITH THE STEEL ROD CONNECTOR



PICTURE 3

VIEW OF THE ADDED TENSION RODS AND THE SADDLE PLATE



PICTURE 4

WEB TO TOP CHORD CONNECTION
WITH THE METAL SEAT AND THE
TENSION ROD VIEW



PICTURE 5
VIEW OF THE TOP CHORD



PICTURE 6

CONNECTOR BOLT, TYP.

SOME OF THE BOLTS NEED TIGHTENING,
SEE ENGINEERS NOTES.



PICTURE T VIEW OF CONNECTOR BOLT, TYP. SOME OF THE BOLTS NEED TIGHTENING, SEE ENGINEERS NOTES.

DATE
MARCH 07, 2005

DRAWN BY
MVA, FB
CHECKED BY
KPA
PROJECT NUMBER
05-09

1894 OPERA HOUSE REMODELING

GRAND STAGE

ASSOCIATES Servation Planning

KILLIS ALMOND

CONSTRUCTION


CONDITIONS NOT FOR


FIELD DOCUMENTATION OF

ANTONIO, TEXAS FAX (210) 532—9

1210) 532-3

A1.5

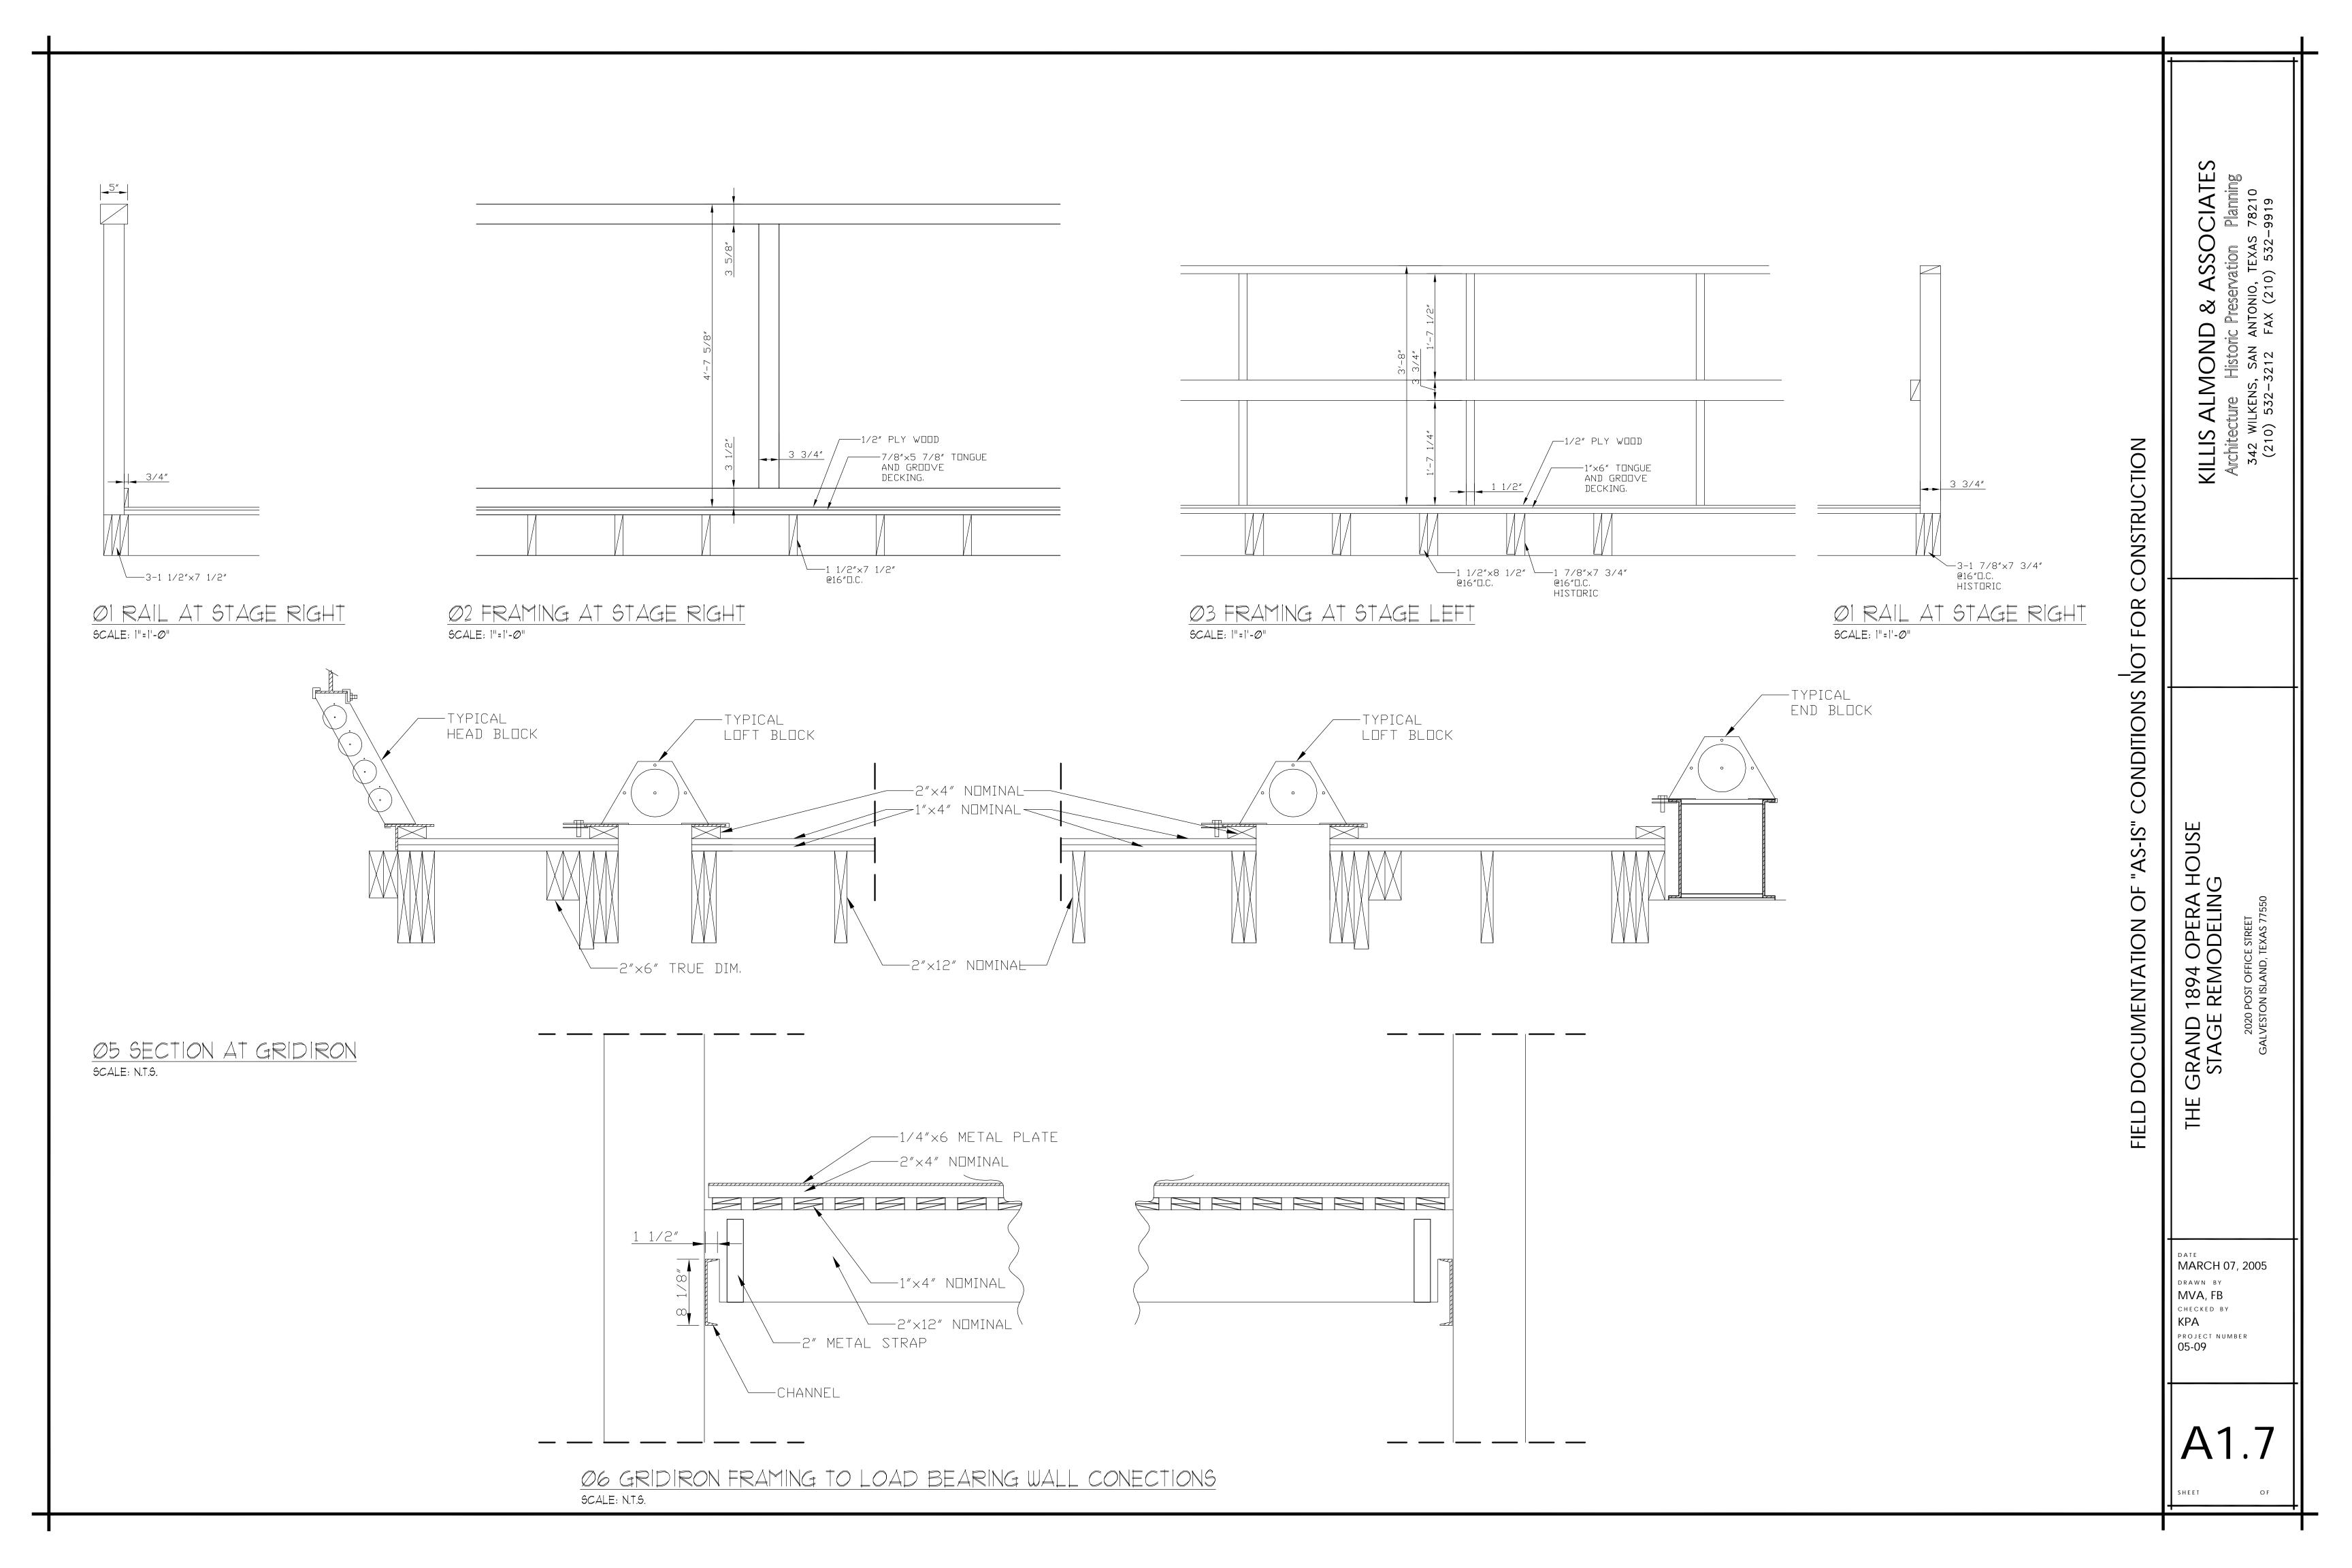

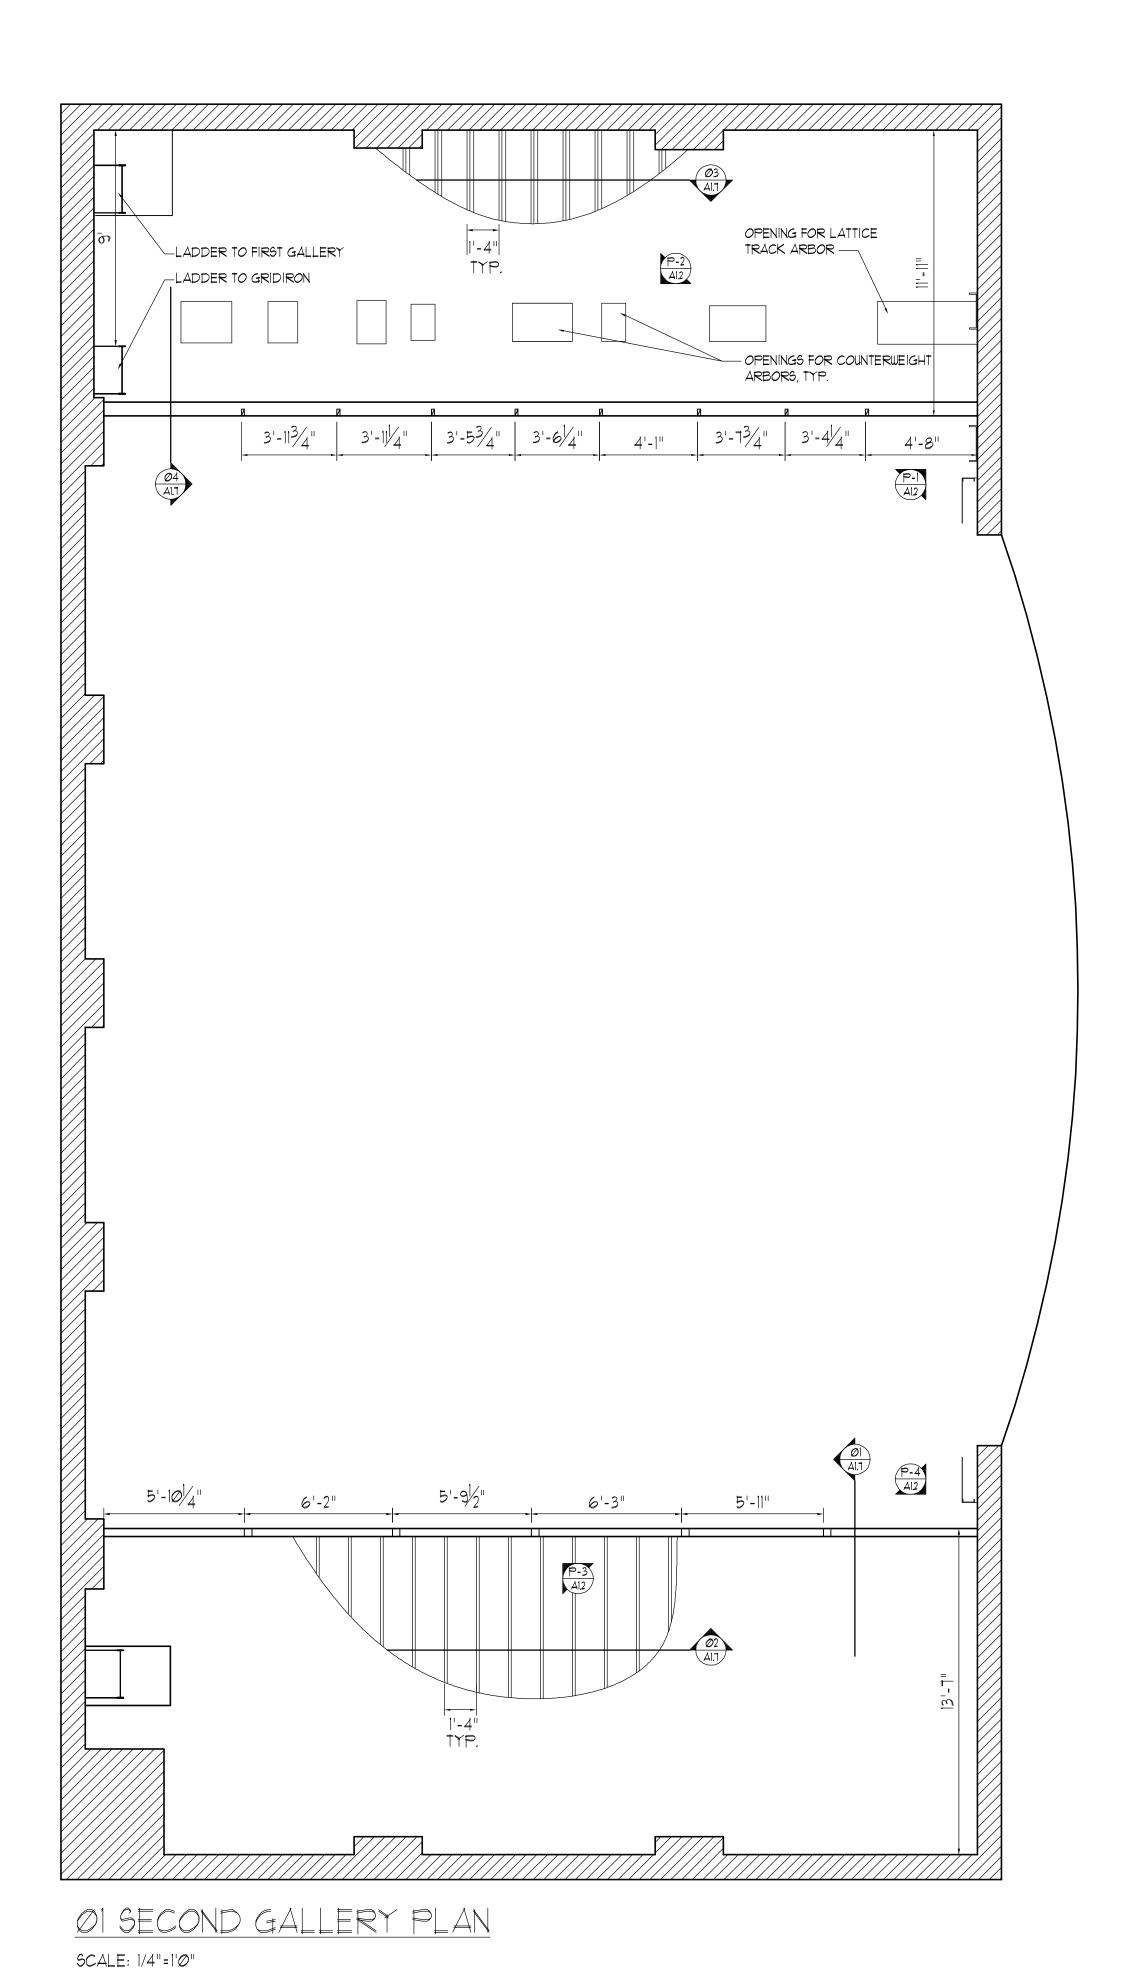

HISTORIC TRUSS -

COMPOSITE HEAD WELL

— DOUBLE CHANNEL HEAD WELL BEAM

DUE TO INACCESSIBILITY THE

LOCATIONS OF THE MEMBERS
ARE DETERMINED BY CAREFUL
VISUAL OBSERVATIONS.

02 GRIDIRON FRAMING PLAN SCALE: 1/4"=1'0"



STAGE LEFT SECOND GALLERY FRAMING TO HISTORIC WALL CONNECTION.



PICTURE 3

STAGE RIGHT SECOND GALLERY FRAMING.




PICTURE 5

GRIDIRON FRAMING AROUND THE HISTORIC TRUSS



PICTURE 7

GRIDIRON FRAMING TO BACK STAGE WALL CONNECTION

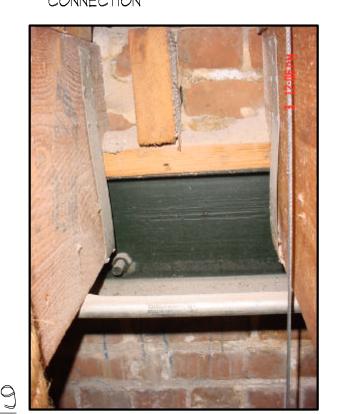

PICTURE 9
HEAD ON VIEW OF THE BACKSTAGE WALL CHANNEL SUPPORTING THE GRIDIRON FRAMING




PICTURE 2

STAGE LEFT SECOND GALLERY FRAMING.



PICTURE 4

STAGE RIGHT HISTORIC HANDRAIL TO LOAD BEARING BRICK WALL CONNECTION.

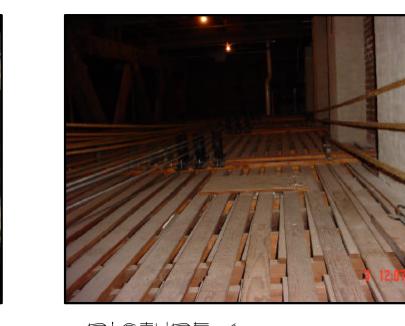

PICTURE 6

GENERAL VIEW OF GRIDIRON



PICTURE 8

GRIDIRON FRAMING AT THE LOFT WELL



GRIDIRON TO BACK STAGE WALL CONNECTION, NOTE THE REMAINS OF OLD TIMBER RESTING IN THE WALL.

KILLIS ALMOND
Architecture Historic I

NOT

ASSOCIATES


STAGE REMODELING


DATE
MARCH 07, 2005

DRAWN BY
MVA, FB
CHECKED BY
KPA
PROJECT NUMBER
05-09

A1.2

ET OF

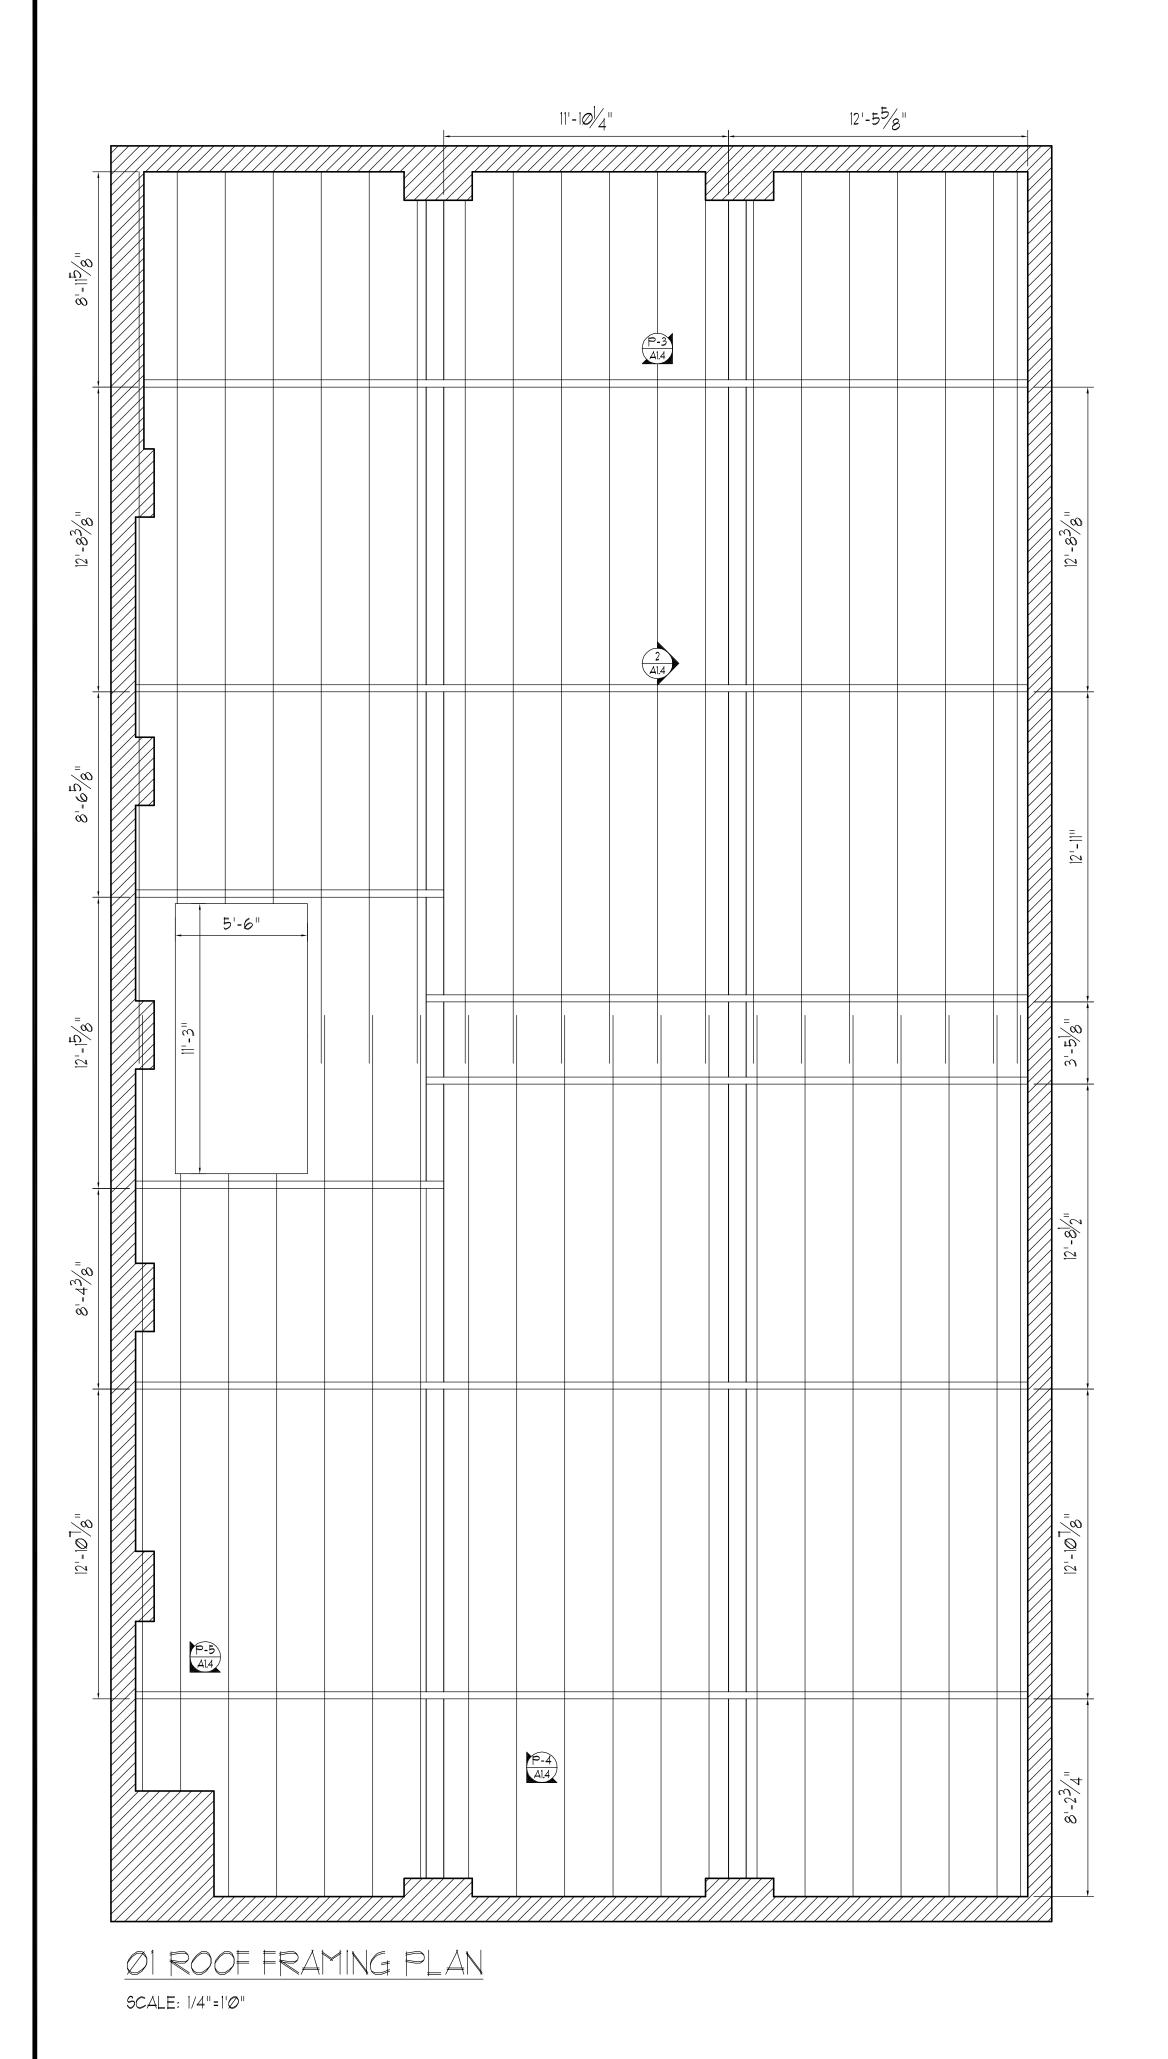

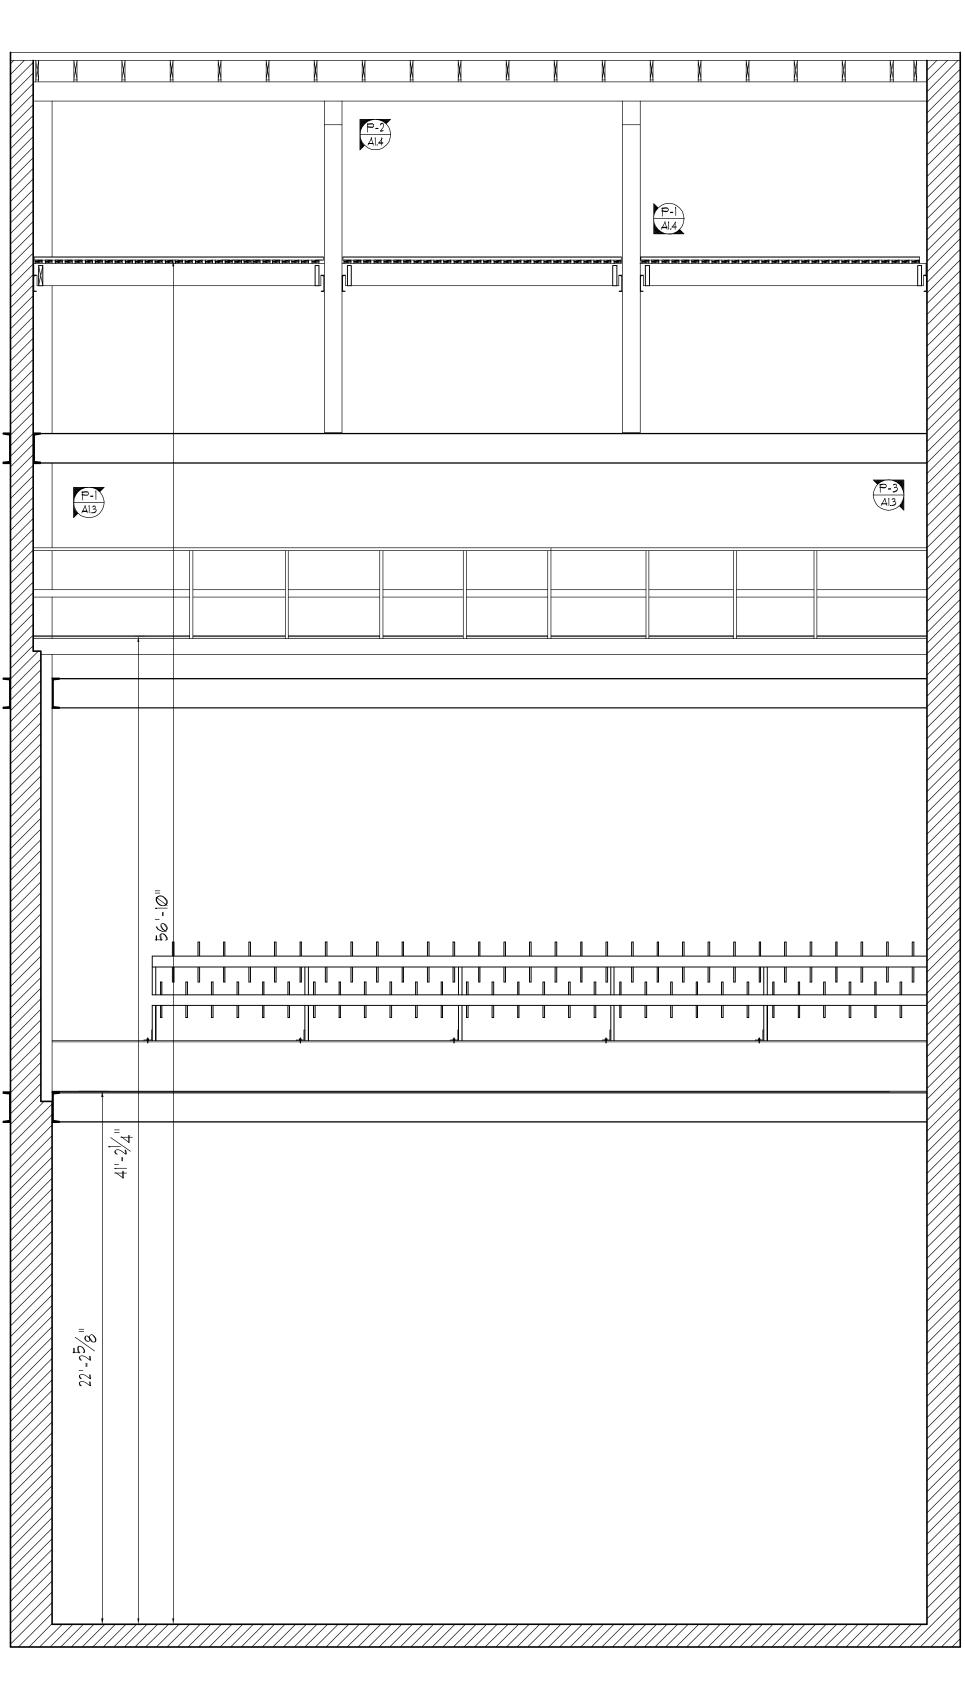


02 STAGE LEFT ELEVATION SCALE: 1/4"=1'0"




PICTURE DOUBLE CHANNEL HEAD BEAMS TO WALL CONNECTION AT BACK OF THE STAGE




PICTURE 3 HEAD BEAMS TO THE STAGE FRONT WALL CHANNEL CONNECTION

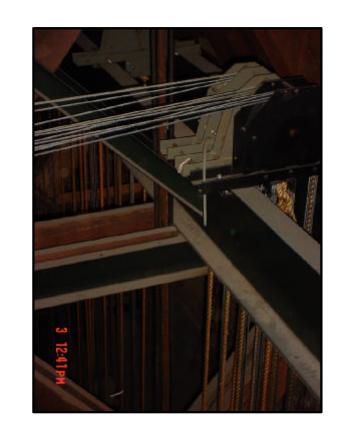


PICTURE 5 BLOCKS TO THE DOUBLE CHANNEL HEAD BEAM CONNECTION

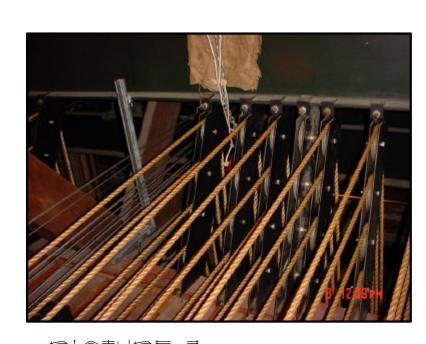

PICTURE T GENERAL VIEW OF HEAD BLOCKS

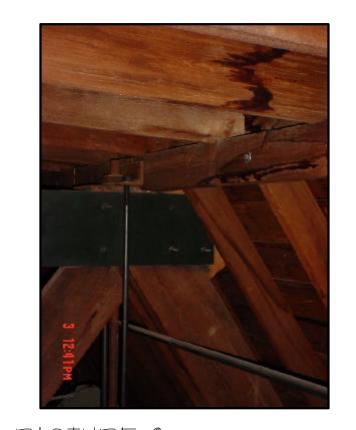

PICTURE 2 MODERN STL. PLATE ON THE TOP CHORD OF THE HISTORIC TRUSS

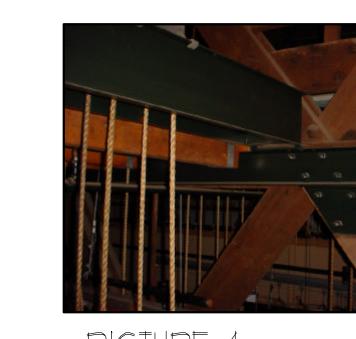

PICTURE 4 ADDITIONAL CHANNELS ON THE N-AXIS OF THE HISTORIC TRUSS AND THE DOUBLE CHANNEL BEAM SUPPORTING THE BLOCKS ON STAGE



PICTURE 6 CONNECTION OF STAGE FRONT CHANNEL TO THE HORIZONTAL MEMBER OF THE HEAD BEAM



PICTURE 8 CONNECTION OF STAGE FRONT CHANNEL TO THE VERTICAL MEMBER OF THE HEAD BEAM

ANTONIO, TEXAS FAX (210) 532-ALMOND 342 WILKEN (210) 532-KILLIS CONDITIONS

CONSTRUCTION

NOT FOR

DOCUMENTATION OF "AS-IS"

FIELD


ASSOCIATES

1894 OPERA HOUSE REMODELING

MARCH 07, 2005 DRAWN BY MVA, FB CHECKED BY KPA project number 05-09

||A1.3

Ø1 SECTIONAL VIEW TOWARDS PROSCENIUM ARCH 9CALE: 1/4"=1"0"

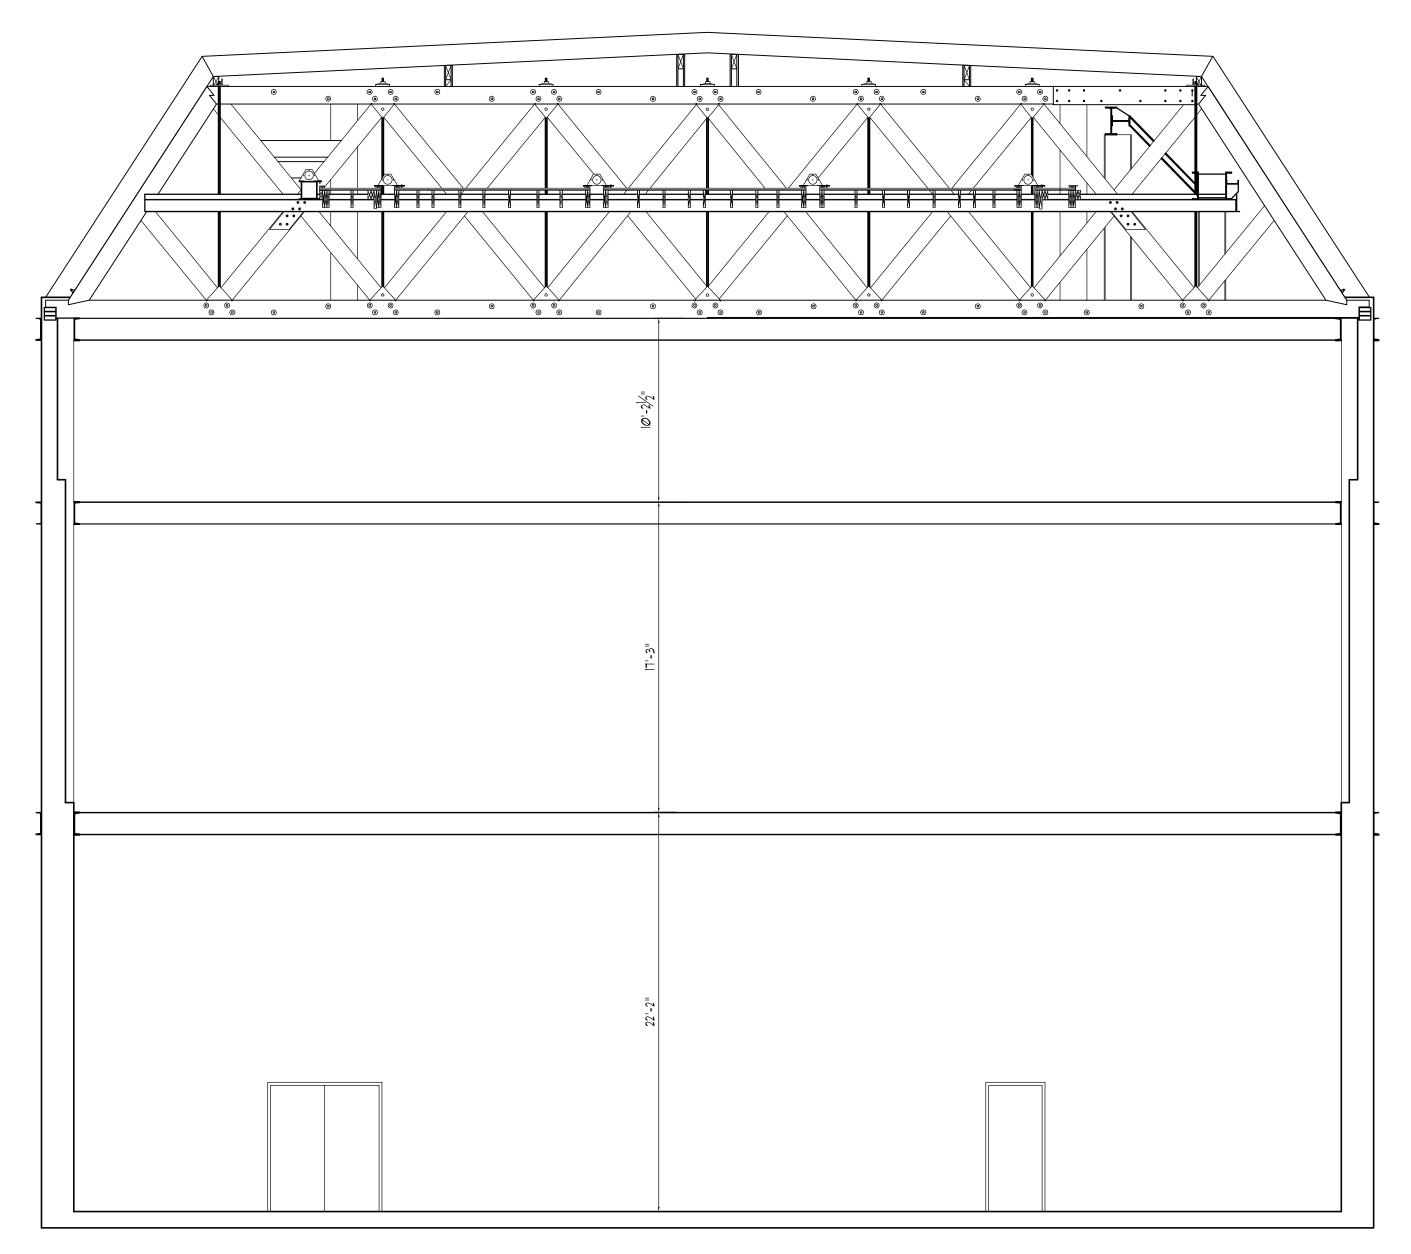

Ø2 SECTIONAL VIEW TOWARDS BACK OF STAGE
SCALE: 1/4"=1'0"



PICTURE 1

TOP VIEW OF THE CONDITION EXPLAINED ON PICTURE 6




PICTURE 2
HISTORIC ROOF RAFTERS ON THE PURLIN



PICTURE 3

BOTTOM VIEW OF THE CONDITION EXPLAINED ON PICTURE 4 @ AI.3

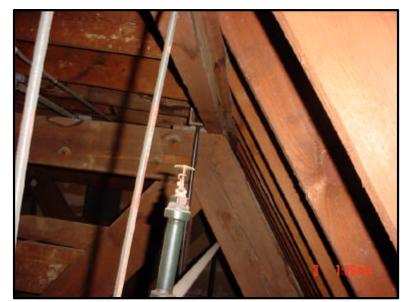

PICTURE 4

ROOF RAFTERS ON THE STAGE RIGHT



PICTURE 5
HISTORIC ROOF PURLIN TO WALL CONNECTION



PICTURE 6
HISTORIC BRICK



PICTURE T

FIELD DOCUMENTATION OF "AS-IS" CONDITIONS NOT FOR CO

KILLIS ALMOND & ASSOCIATES
Architecture Historic Preservation Planning
342 WILKENS, SAN ANTONIO, TEXAS 78210
(210) 532-3212 FAX (210) 532-9919

THE GRAND 1894 OPERA F STAGE REMODELING

DATE
MARCH 07, 2005

DRAWN BY
MVA, FB
CHECKED BY
KPA
PROJECT NUMBER
05-09

A1.4